

THIS DOCUMENT HAS BEEN DIGITALLY SIGNED AND SEALED BY:

Jason Ingram Digitally signed by Jason Ingram Date: 2025.09.26 10:06:20 -04'00'

PRINTED COPIES OF THIS DOCUMENT ARE NOT CONSIDERED SIGNED AND SEALED. THE SIGNATURE MUST BE VERIFIED ON THE ELECTRONIC DOCUMENTS.

TENNESSEE DEPARTMENT OF TRANSPORTATION 7512 VOLKSWAGEN DRIVE CHATTANOOGA, TN

JASON MARK INGRAM, P.E. NO. 00114814

THE ABOVE NAMED PROFESSIONAL ENGINEER SHALL BE RESPONSIBLE FOR THE FOLLOWING SHEETS IN ACCORDANCE OF TENN. CODE ANN. §62-2-306.

YEAR	PROJECT NO.	SHEET NO.	
2025	44S053-M3-005	ROADWAY-SIGN5	

REV. 9/25/25 ADDED SHEET.

STATE OF TENNESSEE
DEPARTMENT OF TRANSPORTATION

SIGNATURE SHEET

## **ROADWAY INDEX**

SHEET NAME

## STANDARD ROADWAY DRAWINGS

DWG.

EC-STR-2

EC-STR-3C

EC-STR-8

EC-STR-37

EC-STR-6A

EC-STR-25

EC-STR-30

REV.

08-01-12

03-01-23

06-10-14

06-10-14

05-06-16

08-01-12

**DESCRIPTION** 

10-107.00 EROSION PREVENTION AND SEDIMENT CONTROL

SEDIMENT FILTER BAG

CONSTRUCTION FORD

FILTER SOCK

SEDIMENT TUBE

SILT FENCE WITH WIRE BACKING

ENHANCED ROCK CHECK DAM

TEMPORARY CULVERT CROSSING, CONSTRUCTION EXIT,

INSTREAM DIVERSION (WITHOUT TRAFFIC)

OHEET WANE	OHLLI IVO.	<b>D110</b> .	IXL V.	DEGGINI HON
SIGNATURE SHEETS	ROADWAY-SIGN1-5			RD ROADWAY TITLE SHEET, ABBREVIATIONS,
TITLE SHEET	1	AND LEGE	ENDS	
ROADWAY INDEX AND STANDARD ROADWAY DRAWINGS	1A	RD-TP-1	10-01-24	STANDARD ROADWAY DRAWINGS TITLE SHEET
STANDARD STRUCTURE AND TRAFFIC DESIGN DRAWINGS	1A3	RD-A-1	02-20-20	STANDARD ABBREVIATIONS A THROUGH L
PROJECT COMMITMENTS	1B	RD-A-2		STANDARD ABBREVIATIONS M THROUGH Z
ESTIMATED ROADWAY QUANTITIES	2	RD-L-1	02-20-20	STANDARD LEGEND
TYPICAL SECTIONS AND PAVEMENT SCHEDULE	2B, 2B1	RD-L-1A		STANDARD LEGEND
GENERAL NOTES	2C	RD-L-2	02-20-20	STANDARD LEGEND FOR UTILITY INSTALLATIONS
SPECIAL NOTES	2D	RD-L-5	07-30-24	STANDARD LEGEND FOR EROSION PREVENTION AND
ENVIRONMENTAL NOTES	2E, 2E1		02 20 20	SEDIMENT CONTROL
TABULATED QUANTITIES	2F	RD-L-6	02-20-20	STANDARD LEGEND FOR EROSION PREVENTION AND SEDIMENT CONTROL
DETAIL SHEETS	2G, 2G1	RD-L-7	02-20-20	STANDARD LEGEND FOR EROSION PREVENTION AND SEDIMENT CONTROL
RIGHT-OF-WAY NOTES, UTILITY NOTES, AND UTILITY OWNERS	3	RD-L-8	02-20-20	STANDARD LEGEND FOR NATURAL STREAM DESIGN
PROPERTY MAP(S) AND RIGHT-OF-WAY ACQUISITION TABLE(S).	3A, 3B			
PRESENT LAYOUT(S)	4		STANDAR	RDS ROADWAY DRAWINGS
PROPOSED LAYOUT(S)	4B	RD11-SE-1		TRANSITION AND CROSS SLOPE DETAILS
PROPOSED PROFILE(S)		RD11-SE-2		SUPERELEVATION TRANSITION DETAILS FOR UNDIVIDED ROADWAYS
HAUL ROAD PROFILE(S)	5	RD11-SE-2A		SUPERELEVATION TRANSITION SECTIONS FOR
DRAINAGE MAP(S)				UNDIVIDED ROADWAYS
CULVERT SECTION(S)	7	RD11-TS-3		DESIGN STANDARD FOR ARTERIAL HIGHWAYS (2-LANE)
EROSION PREVENTION AND SEDIMENT CONTROL PLANS	8 - 13	RD11-LR-2		MINIMUM RUNOFF LENGTHS (LR) FOR RURAL HIGHWAYS
ROADWAY CROSS SECTIONS	14 – 22	RD11-S-11		DESIGN AND CONSTRUCTION DETAILS FOR ROADSIDE SLOPE DEVELOPMENT
TRAFFIC CONTROL PLANS		RD11-S-11A		ROADSIDE DITCH DETAILS FOR DESIGN AND
GEOTECHNICAL PLANS	G-1			CONSTRUCTION
STORM WATER POLLUTION PREVENTION PLAN (SWPPP) PLANS	S-1	10-104.00	SAFETY	DESIGN AND GUARDRAILS
UTILITY PLANS	U1-1	D-NSD-30	05-01-20	SUBSTRATE RESTORATION
NOTE: THE ALPHABETICAL LETTERS "I", "O" & "Q" ARE NOT USE NUMBERING OF SHEETS.	ED IN THE	D-NSD-37	05-01-20	SPECIAL NOTES FOR NATURAL STREAM DESIGN
		10-106.00	SAFETY	DESIGN AND GUARDRAILS
		S-CZ-1	06-28-19	CLEAR ZONE CRITERIA
		S-PL-1	03-01-23	SAFETY PLAN FOR BARRIER LENGTH OF NEED
		S-PL-1B	03-01-23	SAFETY PLAN FOR BARRIER LENGTH OF NEED ON CURVED ROADWAYS
		S-PL-6	07-30-24	SAFETY PLAN SAFETY HARDWARE PLACEMENT ON OUTSIDE EDGE
		S-GR31-1	03-13-25	GUARDRAIL DETAILS
		S-GR31-1A	06-28-19	GUARDRAIL AND BLOCK-OUT DETAILS
		S-GR31-1B		GUARDRAIL FASTENING HARDWARE
		S-GR31-1C	07-07-23	GUARDRAIL GENERAL NOTES AND POST DETAILS
		S-GRS-4	05-04-22	SPECIAL CASE GUARDRAIL HEIGHT TRANSITION DETAIL
		C CDC 0		

S-GRS-8

S-GRT-2

S-GRT-2P

S-GRA-3

S-GRA-4

06-28-19

10-16-20

01-09-24

SHEET NO.

DWG.

REV.

**DESCRIPTION** 

SAFETY PLAN AT SIDEROADS OR DRIVEWAYS FOR LOW

EARTH PAD FOR TYPE 38 AND TYPE 21 TERMINAL

IN-LINE GUARDRAIL ANCHOR TO PRIVATE DRIVE

SPEED ROADWAYS

TYPE 38 GUARDRAIL END TERMINAL

TYPE 13 GUARDRAIL ANCHOR

TYPE	YEAR	PROJECT NO.	NO.	
PS&F	2025	44S053-M3-005	1A	

REV. 8/11/25 ADDED ROADWAY-SIGN2 TO INDEX.

REV. 9/02/25

ADDED ROADWAY-SIGN3 TO INDEX.

REV. 9/5/25 ADDED ROADWAY-SIGN4 TO INDEX.

REV. 9/25/25

ADDED ROADWAY-SIGN5 TO INDEX.

MARK

AGRICUTURE 7

OMMERC 09 26 2025

OF TEXAS

STATE OF TENNESSEE
DEPARTMENT OF TRANSPORTATION

ROADWAY INDEX
AND
STANDARD
ROADWAY
DRAWINGS

	SON_SR53\DGN\SHT- ESTIMATED QUANTITIES.DGN
	ACKSON_
	CE 10.12\CONFIGURATION\WORKSPACES\TDOT_STANDARDS\WORKSETS\136243.00_JA
	KSPACES\TDOT_
	<b>SURATION/WOR</b>
	12\CONFIC
	GNER CE 10
	ROADS DESIG
	PROGRAMDATA\BENTLEY\OPENROADS DESIGNER
4.00.0	MDATA\BENT
07071	PROGRAM

	ITEM NO.	DESCRIPTION	UNIT	QUANTI7 44S053-M3
	105-01	CONSTRUCTION STAKES, LINES AND GRADES	LS	1
1\	201-01 202-01.13	CLEARING AND GRUBBING  PEMOVAL OF RIPE (180" CMR STA 10+60)	LS L.F.	172
1) 1)	202-01.13	REMOVAL OF PIPE (180" CMP, STA. 19+60)  REMOVAL OF PIPE (180" CMP, STA. 19+80)	L.F.	157
3)	203-01	ROAD & DRAINAGE EXCAVATION (UNCLASSIFIED)	C.Y.	17353
4)	203-01	BORROW EXCAVATION (GRADED SOLID ROCK)	TON	1088
+) 4)	203-05	UNDERCUTTING	C.Y.	617
., 5)	203-06	WATER	M.G.	48
2)	203-07	FURNISHING & SPREADING TOPSOIL	C.Y.	195
,	203-08	CHANNEL EXCAVATION (UNCLASSIFIED)	C.Y.	567
3)	203-20.01	CHANNEL SUBSTRATE	C.Y.	287
3)	203-50	CONSTRUCTION OF HAUL ROAD	LS	1
2)	204-08	FOUNDATION FILL MATERIAL	C.Y.	83
9)	209-03.21	FILTER SOCK (12 INCH)	L.F.	250
9)	209-03.31	STREAM MITIGATION-COCONUT FIBER ROLLS	L.F.	200
9)	209-05	SEDIMENT REMOVAL	C.Y.	61
<b>)</b>	209-08.02	TEMPORARY SILT FENCE (WITH BACKING)	L.F.	1198
9)	209-08.08	ENHANCED ROCK CHECK DAM	EACH	16
1)	209-09.03	SEDIMENT FILTER BAG (15' X 15')	EACH	2
2)	209-65.04	TEMPORARY IN STREAM DIVERSION	L.F.	291
2)	303-01	MINERAL AGGREGATE, TYPE A BASE, GRADING D	TON	1612
2)	303-01.01	GRANULAR BACKFILL (ROADWAY)	TON	3911
3)	303-10.01	MINERAL AGGREGATE (SIZE 57)	TON	22
4)	303-10.07	MINERAL AGGREGATE (SIZE 4)	TON	72
2)	307-01.01	ASPHALT CONCRETE MIX (PG64-22) (BPMB-HM) GRADING A	TON	268
2)	307-01.08	ASPHALT CONCRETE MIX (PG64-22) (BPMB-HM) GRADING B-M2	TON	169
4)	402-01	BITUMINOUS MATERIAL FOR PRIME COAT (PC)	TON	4
5)	402-02	AGGREGATE FOR COVER MATERIAL (PC)	TON	13
2)	403-01	BITUMINOUS MATERIAL FOR TACK COAT (TC)	TON	1.3
2)	411-01.10	ACS MIX(PG64-22) GRADING D	TON	176
	411-01.21	LONGITUDINAL JOINT SEALANT	L.M.	0.74
<b>3</b> \	411-12.01	SCORING SHOULDERS (CONTINUOUS) (16IN WIDTH)	L.M.	0.19
2) 7)	415-01.01	COLD PLANING BITUMINOUS PAVEMENT	TON	54
7)	607-50.30 705-02.10	PRECAST CONCRETE BOX BRIDGE (DUAL 18' X 17')	L.F. EACH	96
2)	705-02.10	GUARDRAIL TRANSITION 27IN TO 31IN  EARTH PAD FOR TYPE 38 GR END TREATMENT	EACH	1
3)	705-04.09	GUARDRAIL DELINEATION ENHANCEMENT (BI-DIRECTIONAL)	EACH	100
2)	705-04.22	W BEAM GR (TYPE 2) MASH TL3	L.F.	313
<u>-)</u> 2)	705-06.02	W BEAM GR (TYPE 2) MASH TL-3 (LONG POST)	L.F.	325
-) 2)	705-06.10	GR TERMINALTRAILING END (TYPE 13) MASH TL3	EACH	2
-) 2)	705-06.11	GR TERMINAL (IN-INLINE) MASH TL3	EACH	2
-) 2)	705-06.20	TANGENT ENERGY ABSORBING TERM MASH TL-3	EACH	
2)	706-01	GUARDRAIL REMOVED	L.F.	691
2)	706-06.03	RADIUS RAIL	L.F.	47
3)	707-08.11	HIGH-VISIBILITY CONSTRUCTION FENCE	L.F.	300
9)	709-05.05	MACHINED RIP-RAP (CLASS A-3)	TON	39
2)	709-05.09	MACHINED RIP-RAP (CLASS C)	TON	1183
	712-01	TRAFFIC CONTROL	LS	1
	712-04.01	FLEXIBLE DRUMS (CHANNELIZING)	EACH	25
	712-05.01	WARNING LIGHTS (TYPE A)	EACH	18
	712-06	SIGNS (CONSTRUCTION)	S.F.	829
	712-07.03	TEMPORARY BARRICADES (TYPE III)	L.F.	96
	713-16.01	CHANGEABLE MESSAGE SIGN UNIT	EACH	2
	713-16.50	REMOVE AND REPLACE SIGN (CORP OF ENG SIGN)	EACH	1
	716-01.21	SNOWPLOWABLE RAISED PAVEMENT MARKERS (BI-DIR) (1 COLOR)	EACH	8
)	716-12.02	ENHANCED FLATLINE THERMO PVMT MRKNG (6IN LINE)	L.M.	0.38
	717-01	MOBILIZATION	LS	1
1)	740-10.03	GEOTEXTILE (TYPE III)(EROSION CONTROL)	S.Y.	262
4)	740-10.04	GEOTEXTILE (TYPE IV)(STABILIZATION)	S.Y.	1233
9)	740-11.03	TEMPORARY SEDIMENT TUBE 18IN	L.F.	560
9)	801-01	SEEDING (WITH MULCH)	UNIT	10

ESTIMATED ROADWAY QUANTITIES

		ESTIMATED ROADWAY QUANTITIES	<b>T</b>	
	ITEM NO.	DESCRIPTION	UNIT	QUANTITY 44S053-M3-005
(8)	801-01.07	TEMPORARY SEEDING (WITH MULCH)	UNIT	22
(8)(21)	801-01.38	NATVE SEED MX FINAL STABLIZATN OF SLOPES	UNIT	10.3
(8)(22)	801-03	WATER (SEEDING & SODDING)	M.G.	107
(8)(23)	803-01	SODDING (NEW SOD)	S.Y.	292
(8)(24)	805-12.02	EROSION CONTROL BLANKET (TYPE II)	S.Y.	877

## **FOOTNOTES**

- 1) QUANTITY INCLUDES REMOVAL OF OUTLET CONCRETE APRON.
- (2) SEE SHEET 2F FOR TABULATED QUANTITY.
- (3) SEE GRADING SPECIAL NOTES ON SHEET 2D. QUANTITY INCLUDES REMOVAL OF EXISTING SNOWPLOWABLE MARKERS. EXCAVATED MATERIAL TO BE STOCKPILED ON-SITE WITHIN ROW AND UTILIZED FOR BACKFILL AROUND PROPOSED STRUCTURE AND RECONSTRUCTION OF ROADWAY TO PROPOSED GRADE. ADDITIONAL PAYMENT FOR EMBANKMENT WILL NOT BE MADE. THE COST OF THE EMBANKMENT SHALL BE INCLUDED IN 203-01.
- (4) QUANTITY FOR UNDERCUTTING OF PROPOSED BOX CULVERT AND WINGWALL FOOTPRINTS FOR FOUNDATION STABILIZATION. SEE DETAIL C ON SHEET 7 FOR TYPICAL STABILIZATION SECTION.
- (5) INCLUDES 11 M.G. FOR 303-01 & 37 M.G. FOR EMBANKMENT MATERIAL.
- (6) QUANTITY FOR BACKFILL MATERIAL PROPOSED FOR EMBEDDED CULVERT AND EMBEDDED INLET AND OUTLET RIPRAP.
- (7) THIS QUANTITY INCLUDES GEOTEXTILE (TYPE IV), MACHINED RIP-RAP (CLASS A-1, CLASS B, OR CLASS C), MINERAL AGGREGATE (SIZE 57), AND TEMPORARY DRAINAGE PIPE (IF APPLICABLE). WHEN CONSTRUCTING THE HAUL ROAD. QUANTITY INCLUDES ALL COSTS OF ADJUSTMENT, ADDITIONAL QUANTITIES, AND REMOVAL OF THE HAUL ROAD.
- (8) LUMP SUM QUANTITY IS FOR HAUL ROAD 1 & HAUL ROAD 2.
- (9) SEE SUBSECTION 209.07 OF THE STANDARD SPECIFICATIONS FOR MAINTENANCE REPLACEMENT. ALL QUANTITIES ARE TO BE USED AS DIRECTED BY THE ENGINEER.
- (10) INCLUDES 194 LF FOR SEDIMENT FILTER BAGS.
- (11) PAYMENT SHALL INCLUDE ALL MATERIALS AND LABOR NECESSARY FOR CONSTRUCTION, MAINTENANCE, AND REMOVAL OF SEDIMENT FILTER BAGS.
- (12) INCLUDES 74 LF FOR E.P.S.C. STAGE 2A AND 217 LF FOR E.P.S.C. STAGE 2B.
- (13) QUANTITY FOR SEDIMENT FILTER BAG INSTALLATION.

REQUIREMENT ON STD-17-29 HAS BEEN WAIVED.

- (14) QUANTITIY CALCULATED USING 0.35 GAL/SY.
- (15) ITEM TO BE USED AS DIRECTED BY THE ENGINEER.
- (16) PRECAST WINGWALLS AND WINGWALL FOOTERS ARE INCLUDED IN THE COST OF THIS ITEM.

  QUANTITY LENGTH DOES NOT INCLUDE THE LENGTH FOR THE WINGWALLS.
- (17) THE DESIGN, FABRICATION, AND CONSTRUCTION OF THE PRECAST CONCRETE BOX BRIDGE SHALL CONFORM TO TDOT STANDARD SPECIFICATIONS, INCLUDING APPLICABLE STANDARD DRAWINGS. END SECTIONS SHALL BE PRECAST. CAST-IN-PLACE END SECTIONS
- (18) "HINGED-TYPE" BI-DIRECTIONAL DELINEATORS FROM TDOT'S CURRENT QPL. MOUNTED TO ALL GUARDRAIL POSTS EXCEPT END TERMINAL SECTIONS. ATTACHED TO GUARDRAIL POST AS PER MANUFACTURER'S INSTRUCTION. USE MANUFACTURER'S RECOMMENDED ADHESIVE.
- (19) QUANTITY FOR TEMPORARY CONSTRUCTION ENTRANCE INSTALLATION.
- (20) CONTRACTOR SHALL USE THE EXTRUDED OR RIBBON METHOD FOR APPLICATION.
- (21) QUANTITY INCLUDES 67 SY FOR TEMPORARY CONSTRUCTION ENTRANCES, AND 195 SY FOR SEDIMENT FILTER BAGS.
- (22) PERMANENT STABILIZATION WITH NATIVE OR NATURALIZED PERENNIAL VEGETATION IS REQUIRED IN ALL AREAS AUTHORIZED FOR TEMPORARY AND PERMANENT IMPACTS TO STREAMS AND RIPARIAN AREAS, INCLUDING ADJACENT BUFFER ZONES WITHIN 60 FT OF THE EDGE OF WATER. THE APPROPRIATE SEED MIXTURE FOR THE REGION AND SITE CONDITIONS SHALL BE SELECTED FROM TABLE 7.9-1 (PREFERRED SEED MIXES USING NATIVES OR NATURALIZED PLANTS AND PLANTING DATES) FOUND IN CHAPTER 7.9 (PERMANENT VEGETATION) OF THE TENNESSEE DEPARTMENT OF ENVIRONMENT AND CONSERVATION (TDEC) TENNESSEE EROSION & SEDIMENT CONTROL HANDBOOK 4TH EDITION.
- (23) INCLUDES 2 THOUSAND GALLONS FOR EROSION PREVENTION AND SEDIMENT CONTROL AND 105 THOUSAND GALLONS FOR SEEDING & SODDING.
- 24) SODDING FOR SLOPES SHALLOW THAN 2:1 ONLY.
- THE USE OF DEGRADABLE, PHOTODEGRADABLE, UV-DEGRADABLE, OXO-DEGRADABLE, OR OXO-BIODEGRADABLE PLASTIC NETTING (INCLUDING POLYPROPYLENE, NYLON, POLYETHYLENE, AND POLYESTER) EROSION CONTROL NETTING OR BLANKET IS PROHIBITED IN THE STREAM CHANNEL, STREAM BANKS, WETLANDS, OR ANY DISTURBED RIPARIAN AREAS WITHIN 30 FEET OF TOP OF BANK.

TYPE	YEAR	PROJECT NO.	SHEET NO.
PS&E	2025	44S053-M3-005	2


REV. 8/11/25 UPDATED FOOTNOTE 3. REV. 9/02/25 UPDATED FOOTNOTE 16.

REV. 9/5/25

REMOVED ITEM NO. 604-02.01. UPDATED FOOTNOTE 15 & 16 FOR PRECAST BOX CULVERT END SECTIONS AND WING WALLS. ADDED FOOTNOTE 2 & 15 TO ITEM NO. 607-50.30. UPDATED ITEM NO. 607-50.30 QUANTITY.


REV. 9/25/25


ADDED ITEM NUMBER 203-02.01, 203-05, 303-10.07, & 740-10.04 FOR GEOTECHNICAL RECOMMENDATION FOR BOX CULVERT FOUNDATION. ADDED FOOTNOTE FOR NEW ITEM NUMBERS AND RENUMBERED FOOTNOTES ACCORDINGLY. UPDATED FOOTNOTE 3 TO INCLUDE EMBANKMENT.

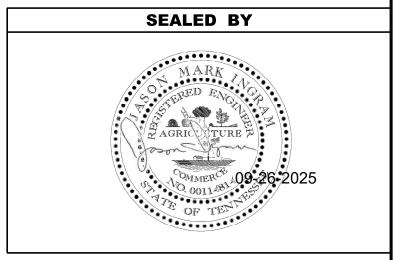


STATE OF TENNESSEE
DEPARTMENT OF TRANSPORTATION

ESTIMATED ROADWAY QUANTITIES

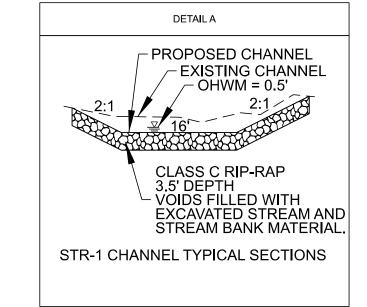

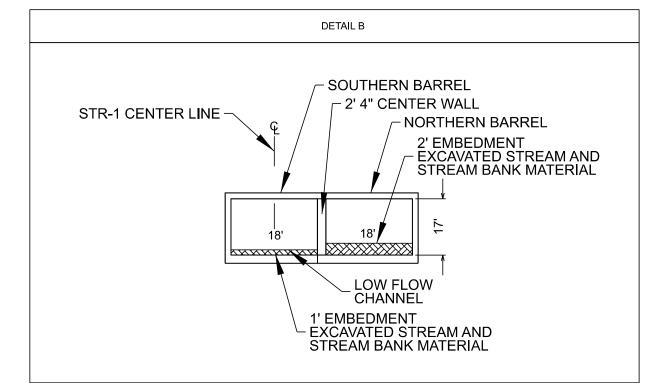

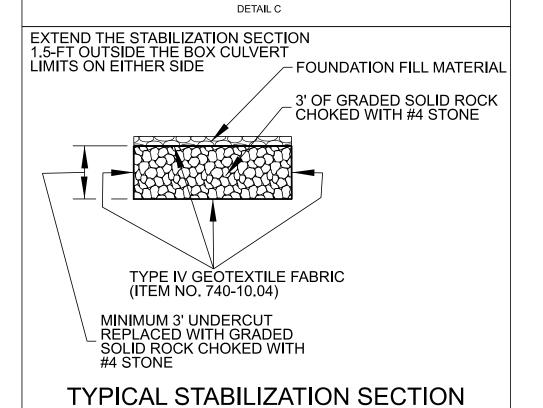

DESIGN DISCHARGE (Q500)

ALLOWABLE HEADWATER

STANDARD DRAWING NOS.: STD-17-29, STD-17-12

OVERTOPPING

Q100 BACKWATER

VELOCITY (Q100)

INLET

OUTLET

2490 CFS AT EL. 511.43

529.93 ELEV.

528.06 ELEV.

12.43 FT/S

502.10 FT.

501.00 FT.

1.36' & EL. 510.07

 TYPE
 YEAR
 PROJECT NO.
 SHEET NO.


 NO.
 NO.
 NO.

REV. 9/5/25


UPDATED LENGTH LABEL ONLY ON PRECAST BOX CULVERT.

REV. 9/25/25

ADDED UNDERCUTTING AND G.S.R. REPLACEMENT UNDER THE CULVERT AND WINGWALL FOOTINGS. ADDED DETAIL C.

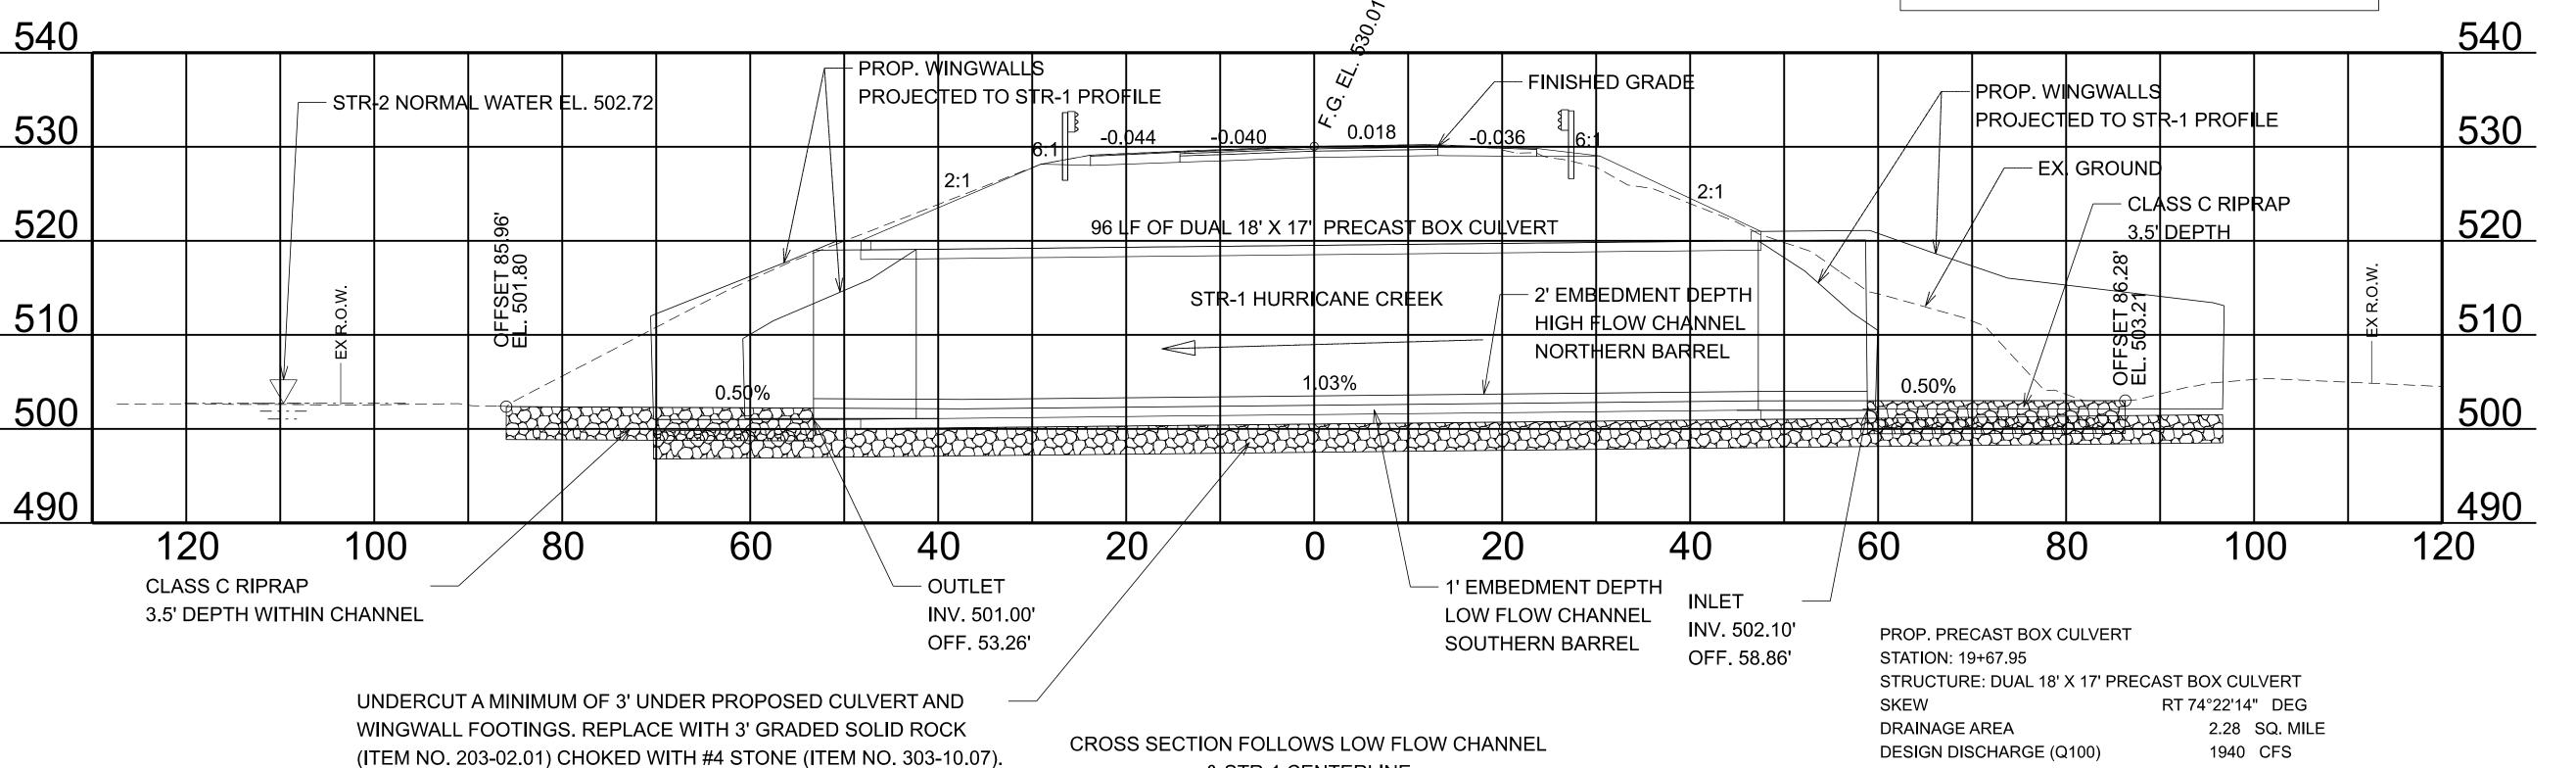

& STR-1 CENTERLINE

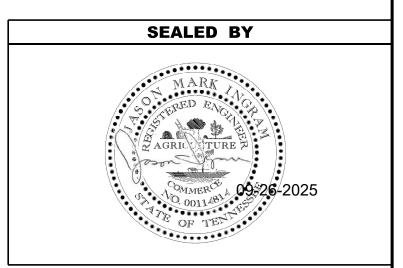

STATE OF TENNESSEE
DEPARTMENT OF TRANSPORTATION

CULVERT SECTION

1" = 10' HORIZ. ALE: 1" = 5' VERT.

SEE DETAIL C ON THIS SHEET.